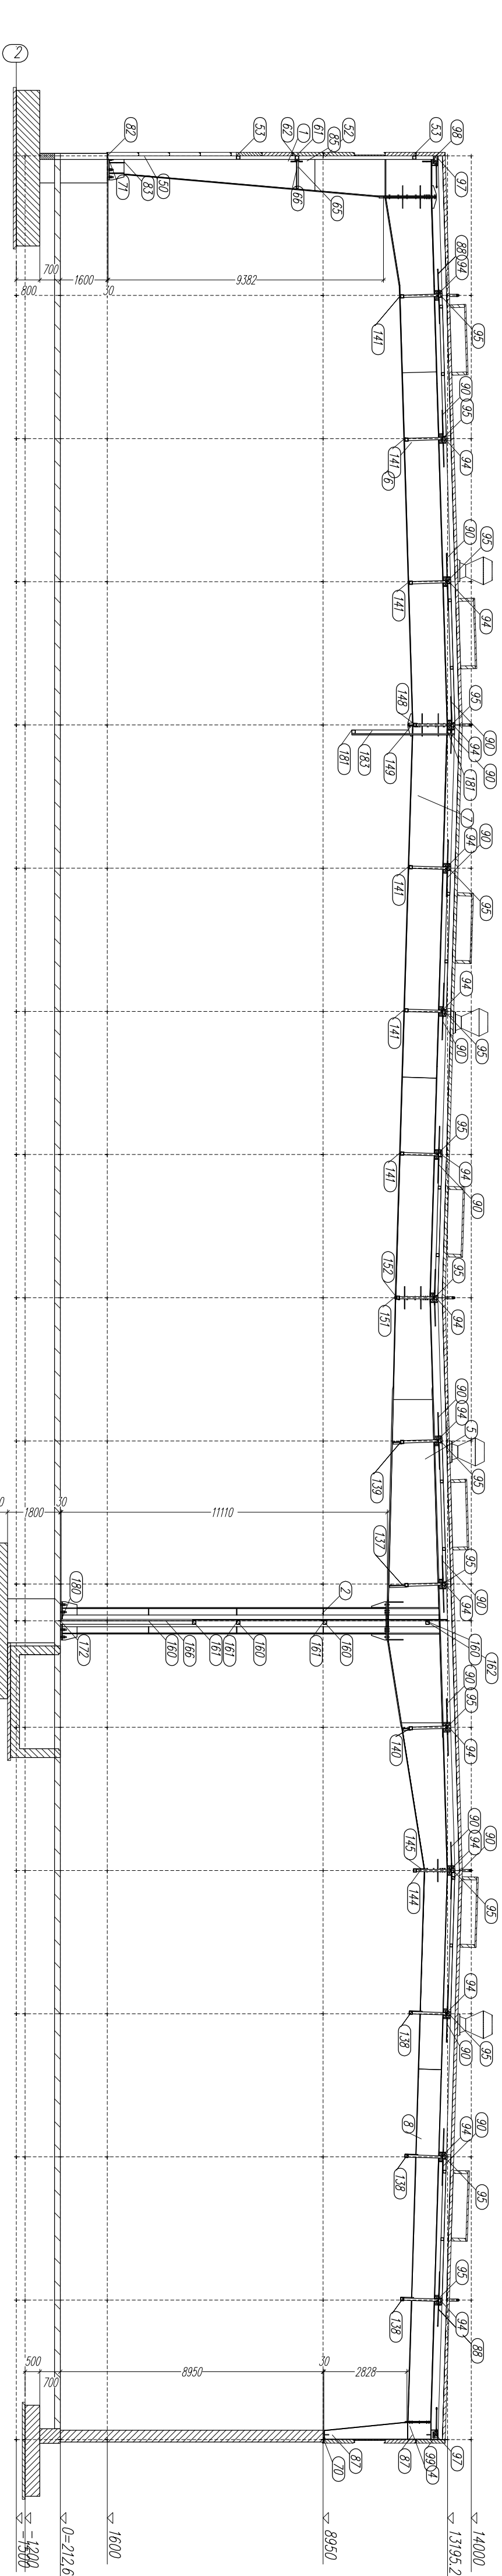


Architectural floor plan of a building, showing a grid system with dimensions and structural details. The plan is oriented horizontally, with the grid lines labeled 1 through 14 along the top and bottom edges, and letters A through L along the left and right edges. The overall dimensions of the building are 14,000 units (width) by 1,400 units (height). The grid segments are dimensioned as follows:

- Horizontal segments (width): 1-2: 1,000; 2-3: 2,200; 3-4: 2,200; 4-5: 2,200; 5-6: 2,200; 6-7: 2,200; 7-8: 2,200; 8-9: 2,200; 9-10: 2,200; 10-11: 2,200; 11-12: 2,200; 12-13: 2,200; 13-14: 2,200.
- Vertical segments (height): A-B: 200; B-C: 200; C-D: 200; D-E: 200; E-F: 200; F-G: 200; G-H: 200; H-I: 200; I-J: 200; J-K: 200; K-L: 200.

The plan includes structural details such as columns, beams, and walls. A scale bar is located at the bottom right of the plan, indicating a scale of 1:100.

[illegible][illegible]

Run	Number of nodes	Run time (min)	Performance				Error	Exponent	Slope	R <sup>2</sup>
			Time	Space	Speed	Memory				
1	16	1.0	1.0	1.0	1.0	1.0	1.0	1.0	1.0	1.0
2	32	1.0	1.0	1.0	1.0	1.0	1.0	1.0	1.0	1.0
3	64	1.0	1.0	1.0	1.0	1.0	1.0	1.0	1.0	1.0
4	128	1.0	1.0	1.0	1.0	1.0	1.0	1.0	1.0	1.0
5	256	1.0	1.0	1.0	1.0	1.0	1.0	1.0	1.0	1.0
6	512	1.0	1.0	1.0	1.0	1.0	1.0	1.0	1.0	1.0
7	1024	1.0	1.0	1.0	1.0	1.0	1.0	1.0	1.0	1.0
8	2048	1.0	1.0	1.0	1.0	1.0	1.0	1.0	1.0	1.0
9	4096	1.0	1.0	1.0	1.0	1.0	1.0	1.0	1.0	1.0
10	8192	1.0	1.0	1.0	1.0	1.0	1.0	1.0	1.0	1.0
11	16384	1.0	1.0	1.0	1.0	1.0	1.0	1.0	1.0	1.0
12	32768	1.0	1.0	1.0	1.0	1.0	1.0	1.0	1.0	1.0
13	65536	1.0	1.0	1.0	1.0	1.0	1.0	1.0	1.0	1.0
14	131072	1.0	1.0	1.0	1.0	1.0	1.0	1.0	1.0	1.0
15	262144	1.0	1.0	1.0	1.0	1.0	1.0	1.0	1.0	1.0
16	524288	1.0	1.0	1.0	1.0	1.0	1.0	1.0	1.0	1.0
17	1048576	1.0	1.0	1.0	1.0	1.0	1.0	1.0	1.0	1.0
18	2097152	1.0	1.0	1.0	1.0	1.0	1.0	1.0	1.0	1.0
19	4194304	1.0	1.0	1.0	1.0	1.0	1.0	1.0	1.0	1.0
20	8388608	1.0	1.0	1.0	1.0	1.0	1.0	1.0	1.0	1.0
21	16777216	1.0	1.0	1.0	1.0	1.0	1.0	1.0	1.0	1.0
22	33554432	1.0	1.0	1.0	1.0	1.0	1.0	1.0	1.0	1.0
23	67108864	1.0	1.0	1.0	1.0	1.0	1.0	1.0	1.0	1.0
24	134217728	1.0	1.0	1.0	1.0	1.0	1.0	1.0	1.0	1.0
25	268435456	1.0	1.0	1.0	1.0	1.0	1.0	1.0	1.0	1.0
26	536870912	1.0	1.0	1.0	1.0	1.0	1.0	1.0	1.0	1.0
27	1073741824	1.0	1.0	1.0	1.0	1.0	1.0	1.0	1.0	1.0
28	2147483648	1.0	1.0	1.0	1.0	1.0	1.0	1.0	1.0	1.0
29	4294967296	1.0	1.0	1.0	1.0	1.0	1.0	1.0	1.0	1.0
30	8589934592	1.0	1.0	1.0	1.0	1.0	1.0	1.0	1.0	1.0
31	17179869184	1.0	1.0	1.0	1.0	1.0	1.0	1.0	1.0	1.0
32	34359738368	1.0	1.0	1.0	1.0	1.0	1.0	1.0	1.0	1.0
33	68719476736	1.0	1.0	1.0	1.0	1.0	1.0	1.0	1.0	1.0
34	137438953472	1.0	1.0	1.0	1.0	1.0	1.0	1.0	1.0	1.0
35	274877906944	1.0	1.0	1.0	1.0	1.0	1.0	1.0	1.0	1.0
36	549755813888	1.0	1.0	1.0	1.0	1.0	1.0	1.0	1.0	1.0
37	1099511627776	1.0	1.0	1.0	1.0	1.0	1.0	1.0	1.0	1.0
38	2199023255552	1.0	1.0	1.0	1.0	1.0	1.0	1.0	1.0	1.0
39	4398046511104	1.0	1.0	1.0	1.0	1.0	1.0	1.0	1.0	1.0
40	8796093022208	1.0	1.0	1.0	1.0	1.0	1.0	1.0	1.0	1.0
41	17592186044416	1.0	1.0	1.0	1.0	1.0	1.0	1.0	1.0	1.0
42	35184372088832	1.0	1.0	1.0	1.0	1.0	1.0	1.0	1.0	1.0
43	70368744177664	1.0	1.0	1.0	1.0	1.0	1.0	1.0	1.0	1.0
44	140737488355328	1.0	1.0	1.0	1.0	1.0	1.0	1.0	1.0	1.0
45	281474976710656	1.0	1.0	1.0	1.0	1.0	1.0	1.0	1.0	1.0
46	562949953421312	1.0	1.0	1.0	1.0	1.0	1.0	1.0	1.0	1.0
47	1125899906842624	1.0	1.0	1.0	1.0	1.0	1.0	1.0	1.0	1.0
48	2251799813685248	1.0	1.0	1.0	1.0	1.0	1.0	1.0	1.0	1.0
49	4503599627370496	1.0	1.0	1.0	1.0	1.0	1.0	1.0	1.0	1.0
50	9007199254740992	1.0	1.0	1.0	1.0	1.0	1.0	1.0	1.0	1.0
51	18014398509481984	1.0	1.0	1.0	1.0	1.0	1.0	1.0	1.0	1.0
52	36028797018963968	1.0	1.0	1.0	1.0	1.0	1.0	1.0	1.0	1.0
53	72057594037927936	1.0	1.0	1.0	1.0	1.0	1.0	1.0	1.0	1.0
54	144115188075855872	1.0	1.0	1.0	1.0	1.0	1.0	1.0	1.0	1.0
55	288230376151711744	1.0	1.0	1.0	1.0	1.0	1.0	1.0	1.0	1.0
56	576460752303423488	1.0	1.0	1.0	1.0	1.0	1.0	1.0	1.0	1.0
57	1152921504606846976	1.0	1.0	1.0	1.0	1.0	1.0	1.0	1.0	1.0
58	2305843009213693952	1.0	1.0	1.0	1.0	1.0	1.0	1.0	1.0	1.0
59	4611686018427387904	1.0	1.0	1.0	1.0	1.0	1.0	1.0	1.0	1.0
60	9223372036854775808	1.0	1.0	1.0	1.0	1.0	1.0	1.0	1.0	1.0
61	18446744073709551616	1.0	1.0	1.0	1.0	1.0	1.0	1.0	1.0	1.0
62	36893488147419103232	1.0	1.0	1.0	1.0	1.0	1.0	1.0	1.0	1.0
63	73786976294838206464	1.0	1.0	1.0	1.0	1.0	1.0	1.0	1.0	1.0
64	147573952589676412928	1.0	1.0	1.0	1.0	1.0	1.0	1.0	1.0	1.0
65	295147905179352825856	1.0	1.0	1.0	1.0	1.0	1.0	1.0	1.0	1.0
66	590295810358705651712	1.0	1.0	1.0	1.0	1.0	1.0	1.0	1.0	1.0
67	1180591620717411303424	1.0	1.0	1.0	1.0	1.0	1.0	1.0	1.0	1.0
68	2361183241434822606848	1.0	1.0	1.0	1.0	1.0	1.0	1.0	1.0	1.0
69	4722366482869645213696	1.0	1.0	1.0	1.0	1.0	1.0	1.0	1.0	1.0
70	9444732965739290427392	1.0	1.0	1.0	1.0	1.0	1.0	1.0	1.0	1.0
71	18889465931478580854784	1.0	1.0	1.0	1.0	1.0	1.0	1.0	1.0	1.0
72	37778931862957161709568	1.0	1.0	1.0	1.0	1.0	1.0	1.0	1.0	1.0
73	75557863725914323419136	1.0	1.0	1.0	1.0	1.0	1.0	1.0	1.0	1.0
74	151115727451828646838272	1.0	1.0	1.0	1.0	1.0	1.0	1.0	1.0	1.0
75	302231454903657293676544	1.0	1.0	1.0	1.0	1.0	1.0	1.0	1.0	1.0
76	604462909807314587353088	1.0	1.0	1.0	1.0	1.0	1.0	1.0	1.0	1.0
77	1208925819614629174706176	1.0	1.0	1.0	1.0	1.0	1.0	1.0	1.0	1.0
78	2417851639229258349412352	1.0	1.0	1.0	1.0	1.0	1.0	1.0	1.0	1.0
79	4835703278458516698824704	1.0	1.0	1.0	1.0	1.0	1.0	1.0	1.0	1.0
80	9671406556917033397649408	1.0	1.0	1.0	1.0	1.0	1.0	1.0	1.0	1.0
81	19342813113834066795298816	1.0	1.0	1.0	1.0	1.0	1.0	1.0	1.0	1.0
82	38685626227668133590597632	1.0	1.0	1.0	1.0	1.0	1.0	1.0	1.0	1.0
83	77371252455336267181195264	1.0	1.0	1.0	1.0	1.0	1.0	1.0	1.0	1.0
84	154742504910672534362390528	1.0	1.0	1.0	1.0	1.0	1.0	1.0	1.0	1.0
85	309485009821345068724781056	1.0	1.0	1.0	1.0	1.0	1.0	1.0	1.0	1.0
86	618970019642690137449562112	1.0	1.0	1.0	1.0	1.0	1.0	1.0	1.0	1.0
87	1237940039285380274899124224	1.0	1.0	1.0	1.0	1.0	1.0	1.0	1.0	1.0
88	2475880078570760549798248448	1.0	1.0	1.0	1.0	1.0	1.0	1.0	1.0	1.0
89	4951760157141521099596496896	1.0	1.0	1.0	1.0	1.0	1.0	1.0	1.0	1.0
90	9903520314283042199192993792	1.0	1.0	1.0	1.0	1.0	1.0	1.0	1.0	1.0
91	19807040628566084398385987584	1.0	1.0	1.0	1.0	1.0	1.0	1.0	1.0	1.0
92	39614081257132168796771975168	1.0	1.0	1.0	1.0	1.0	1.0	1.0	1.0	1.0
93	79228162514264337593543950336	1.0	1.0	1.0	1.0	1.0	1.0	1.0	1.0	1.0
94	158456325028528675187087900672	1.0	1.0	1.0	1.0	1.0	1.0	1.0	1.0	1.0
95	316912650057057350374175801344	1.0	1.0	1.0	1.0	1.0	1.0	1.0	1.0	1.0
96	633825300114114700748351602688	1.0	1.0	1.0	1.0	1.0	1.0	1.0	1.0	1.0
97	1267650600228229401496703205376	1.0	1.0	1.0	1.0	1.0	1.0	1.0	1.0	1.0
98	2535301200456458802993406410752	1.0	1.0	1.0	1.0	1.0	1.0	1.0	1.0	1.0
99	5070602400912917605986812821504	1.0	1.0	1.0	1.0	1.0	1.0	1.0	1.0	1.0
100	10141204801825835211973625643008	1.0	1.0	1.0	1.0	1.0	1.0	1.0	1.0	1.0

[illegible]

UWAGA : DO WASY KONSTRUKCJI NALEŻY DODAC 5% NA SPŁATY, ŚRUBY

[illegible]

INWESTYCJA: Zakład Zagospodarowania i Unieszkodliwiania Odpadów Innych niż niebezpieczne i obojętne w m. Dyków "A", gm. Pajęczno działek nr 15, 16, 17, 18, 19, 20, 21, 22, 23, 24, 25 obr. Dyków "A"	INWESTOR: Eko-Region Sp. z o.o., ul. Bawenińska 18 97-400 Bełchatów
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**JEDYNOŚĆ PROJEKTOWA**

**PROJEKT**

**„UKŁON PROJEKT”**

**PRZEDSIĘWZIĘCIE PROJEKTOWE**

**I NAZWA**

**PROJEKT**

97-400 Białoboków, ul. L.M. Kasprzaka, 1b, 530-00-55, email: biuro@uklonprojekt.pl, www.uklonprojekt.pl

**IMIĘ NAZISKO**

**PROJEKTANT** mgr inż. ARSŁAW ARSŁAK

**SWIADOMYŚĆ** LODOŚ SWIADOMYŚĆ

**WYKONAWCA** mgr inż. TOMASZ SZYDŁO

**PROJEKTOWA** mgr inż. ANNA GRZEJKA

**ASISTENT** mgr inż. MATYŁDEJ BARTŁA

**PROJEKTANT**

IMIĘ NAZISKO	MIEJSCE	DATA	PODZISK
mgr inż. ARSŁAW ARSŁAK			
LODOŚ SWIADOMYŚĆ			
mgr inż. TOMASZ SZYDŁO			
mgr inż. ANNA GRZEJKA			
mgr inż. MATYŁDEJ BARTŁA			

HALA SORTOWNI	DATA:	1
FAZA: <b>PROJEKT WYKONAWCZY</b>		
BRANŻA: KONSTRUKCYJNA	SKALA: 1:150	
TRESC PRZELICZUNKU: RZUT KONSTRUKCYJALNY DACHU PRZECIWK W OŚI 2	NR PRZELICZUNKU: <b>B3.K02</b>	